MONTGOMERY COUNTY MARYLAND SOLICITATION ADDENDUM #1 IFB #1007870 6/27/2011

FOR THE PROCUREMENT OF: Fire Station I	No. 19 Roof Replacement.
ALL SOLICITATION ADDENDUMS MUST BE PRIOR TO THE HOUR AND DATE SPECIFIE AMENDED) FOR RECEIPT OF BIDS. FAILU ADDENDUM MAY BE CAUSE TO REJECT 1	ACKNOWLEDGED BY THE BIDDER DO IN THE SOLICITATION (AS RE TO ACKNOWLEDGE AN THE BID.
DESCRIPTION OF ADDENDUM:	·
Changes:	
1) Add drawings for the project in full-si	ze (34" x 22") format. Attached.
THE SOLICITATION PROVISION ENTITLED APPLICABLE TO THIS ADDENDUM. THE CHEREBY INCORPORATED INTO THE ABOVAND DATE SPECIFIED FOR RECEIPT OF B	HANGES SET FORTH BELOW ARE 'E-CITED SOLICITATION. THE HOUR
	BY: Con Collins David E. Dise, CPPO, Director Department of General Services
NAME OF BIDDER:	
(Type or print)	
NAME AND TITLE OF PERSON AUTHORIZED TO SIGN BID:	
(Type or Print)	
BIDDER'S SIGNATURE	
DATE	

(Collins)

IFB # 1007870 FIRE STATION NO. 19 ROOF REPLACEMENT Addendum No. 1

This addendum is supplemental to Invitation for Bids (IFB) No. 1007870. All changes, deletions and additions shall be part of the contract as if originally shown in IFB No. 1007870.

<u>Item No. 1</u> – Attached to this Addendum are the drawings for the project in full-size (34" x 22") format.

IFB# 1001994 ROOF REPLACEMENT FIRE STATION #19

1945 SEMINARY ROAD SILVER SPRING, MARYLAND 20910

PREPARED FOR MONTGOMERY COUNTY, MARYLAND


DRAWING NO	<u>TITLE</u>
G-001	COVER SHEET
G-002	STANDARD ABBREVIATIONS, LEGNED, SYMBOLS AND GENERAL NOTES
C-101	SITE PLAN
A-101	ROOF AREA PLAN EXISTING CONDITIONS
A-102	ROOF AREA PLAN NEW CONSTRUCTION
A-401	CONCEPTUAL TAPERED INSULATION PLAN
A-301	ROOF SECTIONS CROSS-SECTION
A-501	TYPICAL ROOF/FLASHING DETAILS
A-502	DETAILS EXISTING CONDITIONS
A-503	DETAILS EXISTING CONDITIONS
A-504	DETAILS NEW CONSTRUCTION
A-505	DETAILS NEW CONSTRUCTION
A-506	DETAILS NEW CONSTRUCTION
A-507	DETAILS NEW CONSTRUCTION
A-508	DETAILS NEW CONSTRUCTION









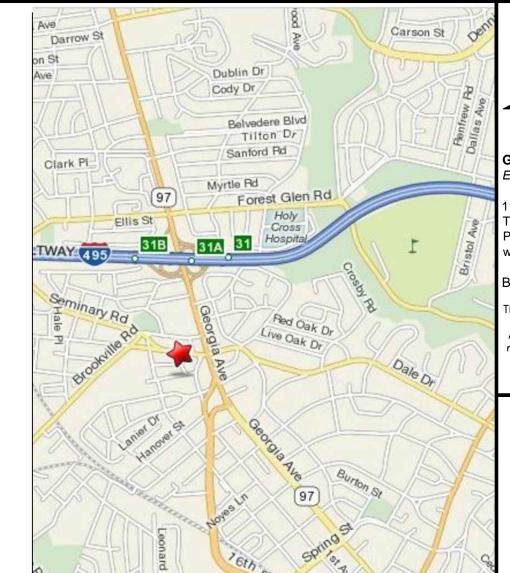

LOCATION MAP



Gale Associates, Inc.
Engineers Architects Planners

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Boston Baltimore Orlando San Francis

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PROJECT	ROOF REPLACEMENT FIRE STATION #19	SI VER SPRING MARYI AND 20910		OWNER	MONTGOMERY COLINTY MARYLAND	DIV. OF BUILDING DESIGN & CONSTRUCTION
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COVER SHEET

12/5/07

DRAWING SCALE | N.T.S.

GRAPHIC SCALE

SHEET TITLE

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	4	$^{\circ}$	1 =

STANDARD LEGEND

NOTE: NOT ALL SYMBOLS NECESSARILY USED

	ROOF EDGE
	EXPANSION JOINT
	PARAPET
•	GUTTER WITH DOWNSPOL
	RIDGE LINE
	CONTROL JOINT
· · ·	CONDUIT

CHIMNEY

FAN

CRICKET

Н

SKYLIGHT

VENT

HATCH

 $\overline{\vee}$

RTU ROOF TOP MECHANICAL UNIT

ROOF DRAIN WITH SUMP

ELECTRICAL PENETRATION

MECHANICAL PENETRATION

MAIN ENTRANCE

HOT PIPE

LADDER

UNKNOWN PENETRATION TYPE

A

Ø PIPE PENETRATION

<u>Γ</u>

LIGHT POURAE

POURABLE SEALER POCKET

ROOF DRAIN

AUGMENTING ROOF DRAIN

OVERFLOW SCUPPER

STRUCTURAL SLOPE

TAPERED INSULATION SLOPE

-\_A

SCUPPER

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· -> ->

SUPPORTVENT PIPE

VENT PIPE ELEVATION MARK

STANDARD ABBREVIATIONS

NOTE: NOT ALL ABBREVIATIONS NECESSARILY USED

AIR CONDITIONER UNIT ALUMINUM AREA DRAIN ΑD BASE FLASHING BRICK MASONRY UNIT BMU BUILDING BLDG BUILT-UP ROOFING BUR CEMENTITIOUS WOOD FIBERBOARD CWF CLADDING CLDG CLEAT CLT CONCRETE CONC CONCRETE MASONRY UNIT CMU CONTINUOUS CONT COUNTERFLASHING CF COVER CV DOWNSPOUT DS ELEVATION EL EQ EQUAL ETHYLENE PROPYLENE EPDM DIENE MONOMER EXISTING ΕX EXPANSION JOINT EJ EXTERIOR EXT EXTERIOR INSULATION EIFS FINISH SYSTEM FASTENER **FSTNR** FIRE RETARDANT TREATED FRT FOOT FΤ GLAZING GLZ GYPSUM GYP INCH INTERIOR INT INSULATION INSUL LADDER LAD LIGHTNING LTNG LIGHTWEIGHT CONCRETE LWC LIGHTWEIGHT LT WT MAXIMUM MAXMECHANICAL MECH MEMB MEMBRANE METAL MTL MINIMUM MIN NOT IN CONTRACT NIC NOT TO SCALE NTS NUMBER NO PLYWOOD PLYWD ROOF DRAIN RD RTU ROOF TOP UNIT SELF-ADHERING MODIFIED SAMB BITUMEN SHEET METAL SHEET SHT SIMILAR SIM SLEEVE SLV STANDING SEAM (ROOF) SS SST STAINLESS STEEL STEEL STL STRUCTURAL STRUCT TYP TYPICAL WINDOW


WD

WOOD

WOODFIBER BOARD

STANDARD SYMBOLS

NOTE: NOT ALL SYMBOLS NECESSARILY USED

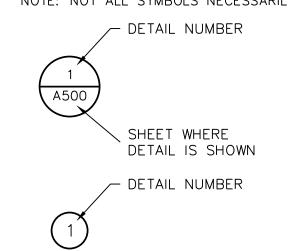


SECTION IDENTIFIER

DETAIL INDICATORS

S A300 SHEET WHERE SECTION IS SHOWN


SECTION INDICATOR

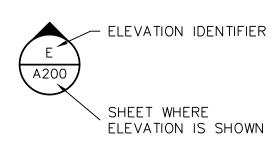

ELEVATION INDICATOR

STANDARD HATCH PATTERNS


NOTE: NOT ALL HATCH PATTERNS NECESSARILY USED

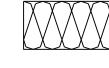


BATT INSULATION



CELLULAR FOAM INSULATION

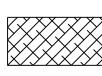


CEMENTITIOUS WOODFIBER BOARD

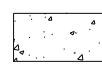


CONCRETE



FIBERGLASS INSULATION

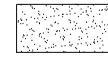


GYPSUM BOARD/DECK

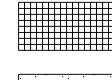

LIGHTWEIGHT CONCRETE

ISOCYANURATE INSULATION

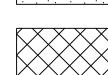

WOOD FIBERBOARD INSULATION

GENERAL NOTES

- 1. THE BUILDING SHALL BE MADE 100% WEATHERTIGHT ON A DAILY BASIS. PHASED CONSTRUCTION SHALL ONLY BE AS INDICATED, OR AS PREVIOUSLY APPROVED BY THE OWNER. DEVIATIONS MUST BE APPROVED BY THE OWNER PRIOR, TO CONSTRUCTION.
- 2. DISCONNECT, REMOVE, RAISE, REINSTALL AND RECONNECT EXISTING ROOFTOP EQUIPMENT AND ASSOCIATED MECHANICAL/ELECTRICAL PENETRATIONS AS REQUIRED TO PERFORM WORK.
- 3. THE CONTRACTOR SHALL REPORT DETERIORATED OR UNSUITABLE STRUCTURAL FRAMING OR DECKING TO THE OWNER PRIOR TO THE INSTALLATION OF THE NEW ROOF ASSEMBLY.
- 4. THE INFORMATION SHOWN ON THE DRAWINGS HAS BEEN COMPILED FROM VARIOUS SOURCES, AND MAY NOT REFLECT THE ACTUAL CONDITIONS AT THE TIME OF CONSTRUCTION.
- 5. REMOVE AND DISPOSE OF ABANDONED PENETRATIONS AND OTHER EQUIPMENT WHERE INDICATED.
- 6. DISCREPANCIES NOTED BY THE CONTRACTOR IN THE DRAWINGS OR SPECIFICATIONS MUST BE BROUGHT TO THE OWNER'S ATTENTION PRIOR TO BID SUBMISSION.
- 7. FOR THE SAKE OF CLARITY, EACH INDIVIDUAL DETAIL ON THE ROOF PLAN HAS NOT BEEN INDICATED. INSTALLATION DETAILS HAVE BEEN INDICATED FOR TYPICAL COMPONENTS AT RANDOM LOCATIONS.
- 8. COMPONENTS SHOWN ON THE DETAIL DRAWINGS SHALL BE NEW UNLESS SPECIFICALLY INDICATED AS EXISTING. REFER TO SPECIFICATIONS FOR MATERIALS.
- 9. DETAILS NOT DEPICTED SHALL BE CONSTRUCTED IN A MANNER CONSISTENT WITH THE DETAIL DRAWINGS.
- 10. FOR THE SAKE OF CLARITY, SECUREMENT FASTENERS ARE NOT SHOWN ON THE DETAIL DRAWINGS. REFER TO THE SPECIFICATIONS FOR FASTENER TYPES AND SPACING.
- 11. ITEMS OF CONSTRUCTION SHALL BE IN ACCORDANCE WITH LOCAL, STATE AND FEDERAL REGULATIONS APPLICABLE TO THE PROJECT.
- 12. THE OWNER WILL CONTROL OCCUPANCY IN THE BUILDING BASED ON THE PHASING SCHEDULE DETERMINED PRIOR TO THE START OF WORK.
- 13. PROVIDE INTERIOR PROTECTION AS REQUIRED TO PREVENT DAMAGE TO FLOORING, WALL SURFACES AND OTHER MATERIALS.
- 14. REMOVE AND STORE ALL ITEMS WITHIN THE BUILDING, AS NECESSARY FOR INTERIOR WORK, ITEMS SHALL BE STORED IN PORTABLE STORAGE UNIT PROVIDED BY THE CONTRACTOR.
- 15. TAKE CARE SO AS NOT TO DAMAGE EXISTING ROOF TOP EQUIPMENT NOT SCHEDULED FOR DISPOSAL. REPORT DAMAGED OR DETERIORATED CONDITIONS PRIOR TO THE START OF WORK.
- 16. MAINTAIN DRIVEWAYS AND GROUNDS FREE OF DEBRIS AND FASTENERS. FLAT TIRES ON FIRE EQUIPMENT CAUSED BY CONTRACTOR DEBRIS SHALL BE REPLACED AT NO EXPENSE TO THE OWNER.



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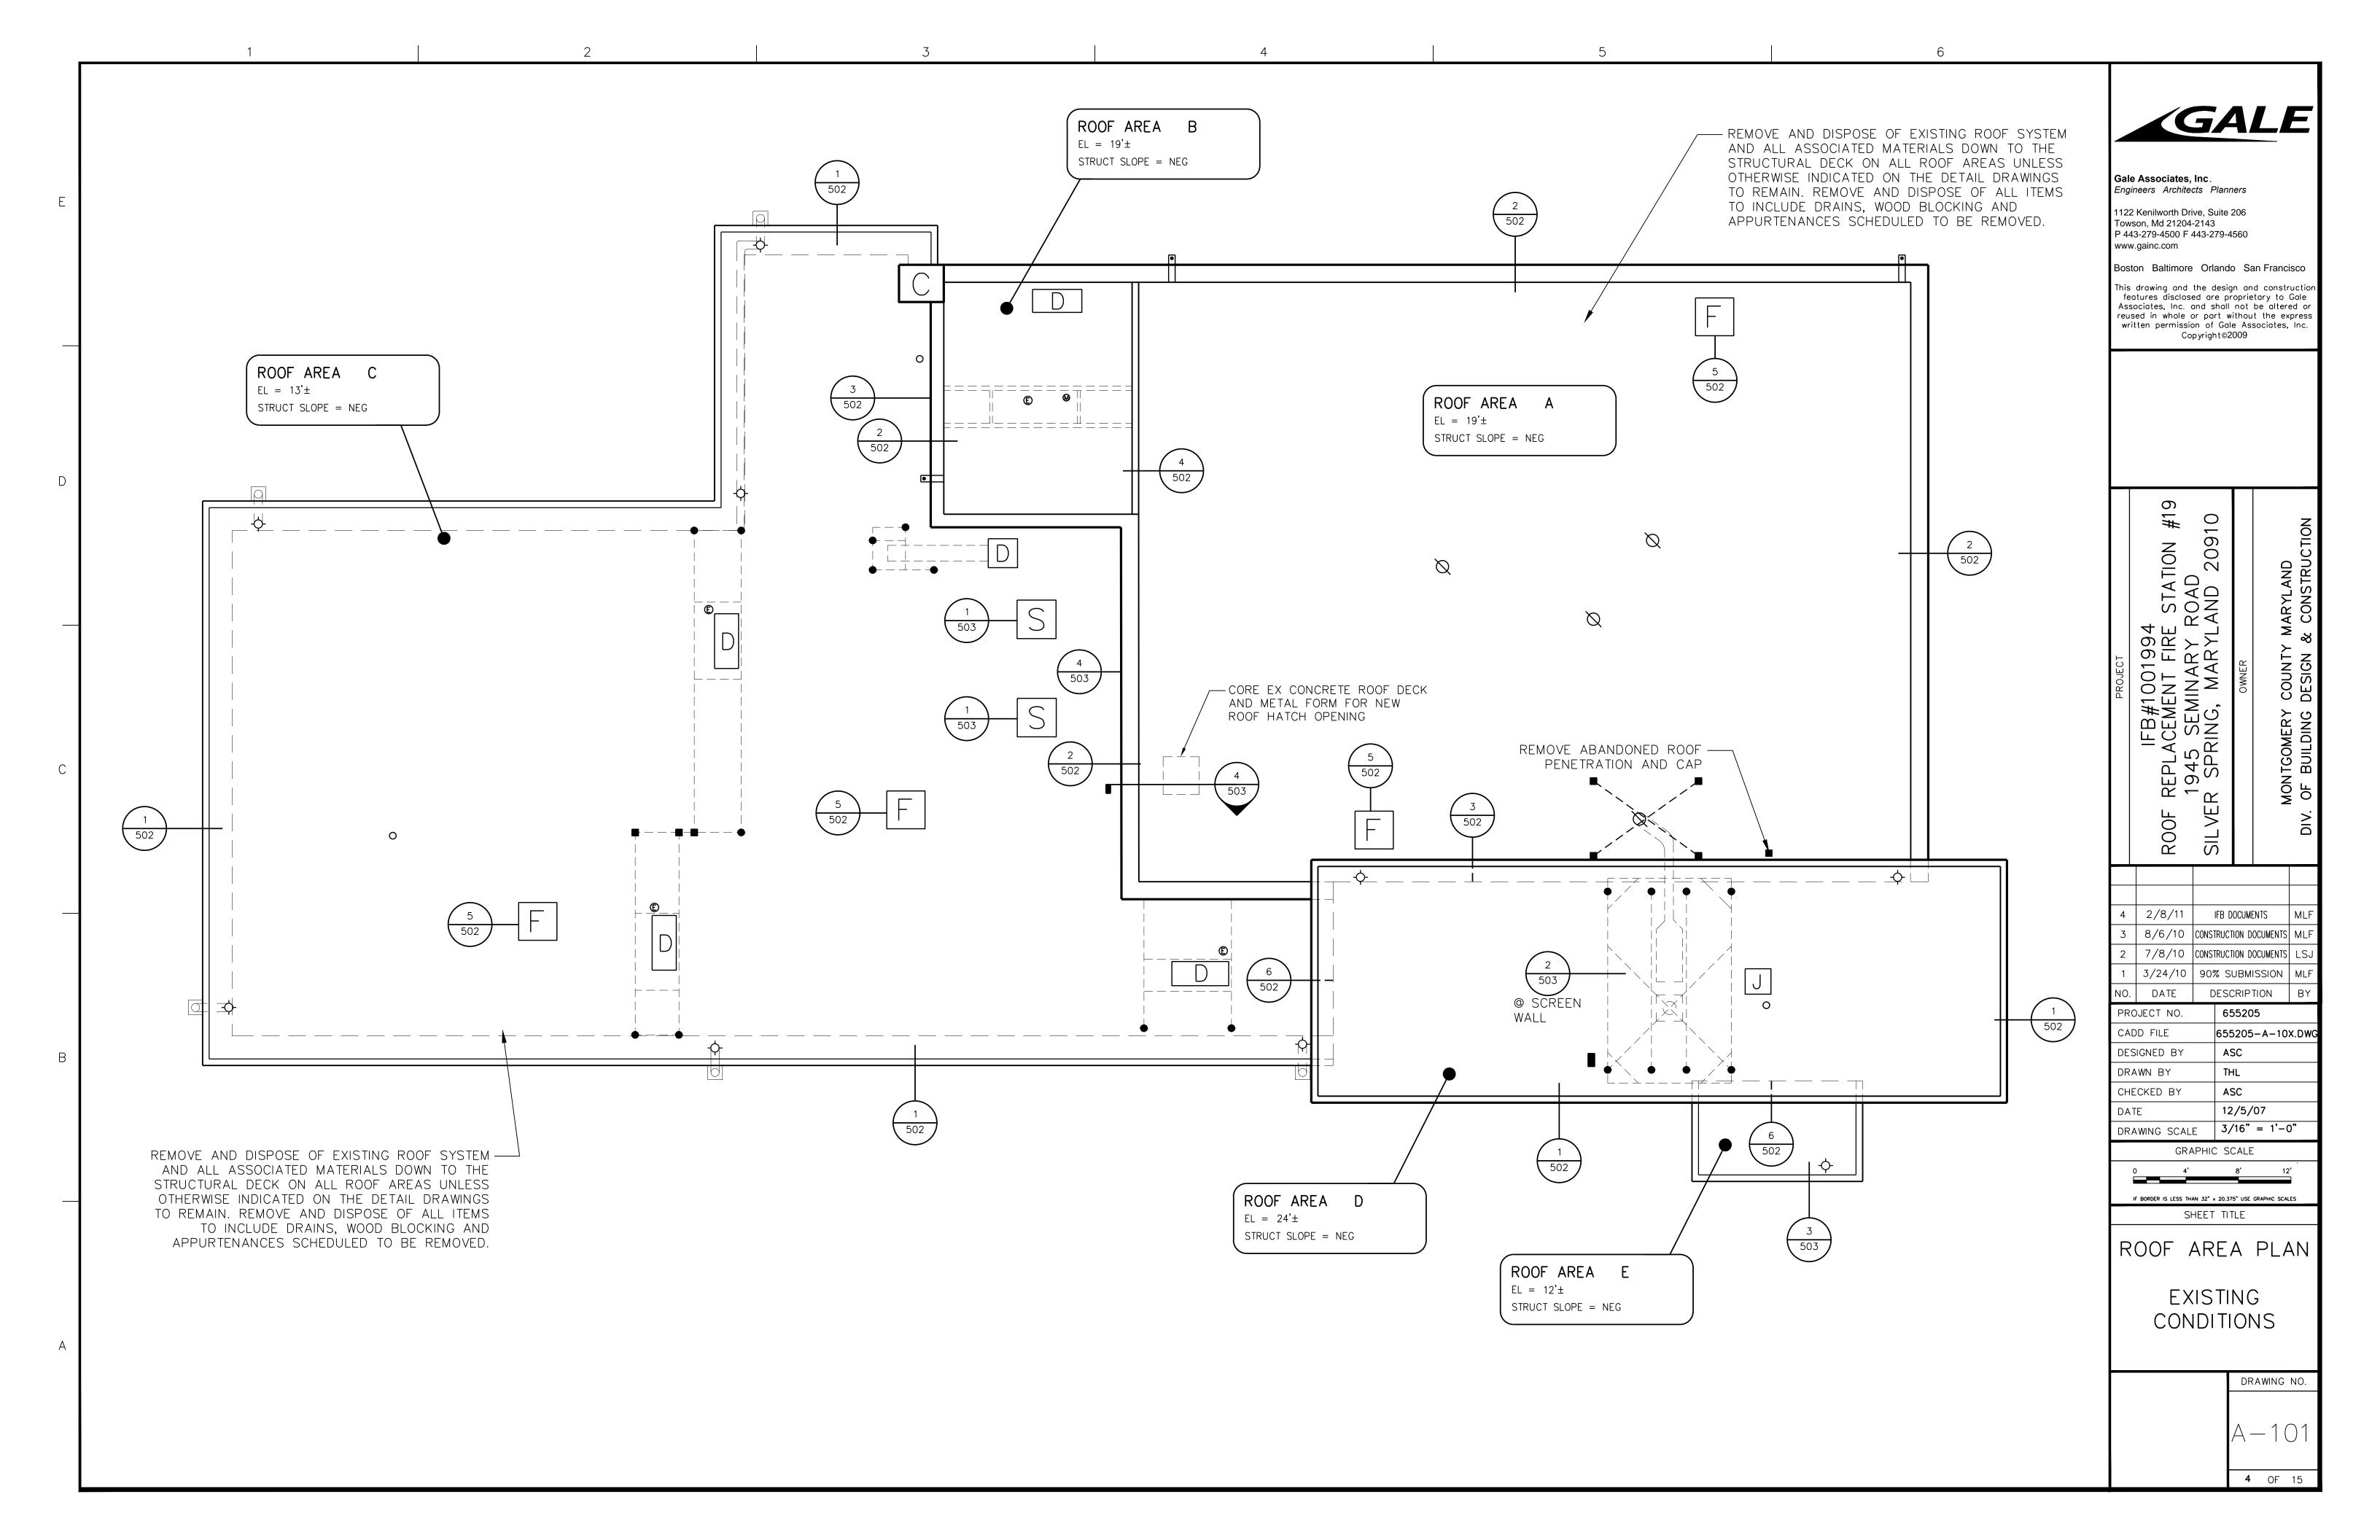
STANDARD
ABBREVIATIONS,
LEGEND, SYMBOLS
AND
GENERAL NOTES


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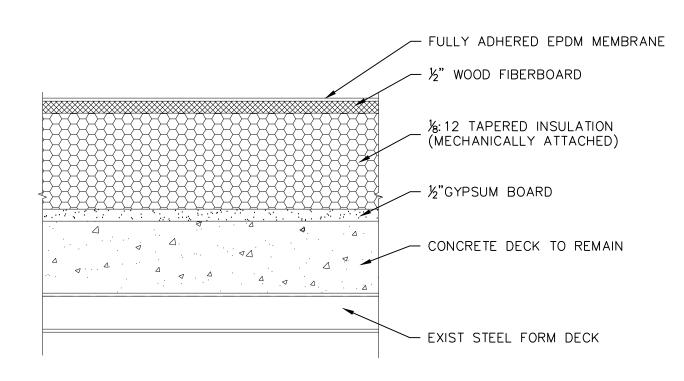
2 OF 15

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Copyright@2009 SHED 20910 IFB#1001994 OOF REPLACEMENT FIRE STATION # 1945 SEMINARY ROAD ILVER SPRING, MARYLAND 2091(\Diamond ROOF SIL IFB DOCUMENTS 8/6/10 | CONSTRUCTION DOCUMENTS | ML 7/8/10 CONSTRUCTION DOCUMENTS 3/24/10 | 90% SUBMISSION | ML NO. DATE DESCRIPTION PROJECT NO. 655205 CADD FILE 655205-C-101.DWG DESIGNED BY ASC DRAWN BY CHECKED BY ASC 12/5/07 DRAWING SCALE 3/32" = 1' SEMINARY ROAD GRAPHIC SCALE IF BORDER IS LESS THAN 32" x 20.375" USE GRAPHIC SCALES SHEET TITLE SITE PLAN NOTES: STAGING/STORAGE AREA DRAWING NO. PROVIDE OVERHEAD PROTECTION AT ENTRANCES FOR DURATION OF WORK ON ROOF AREA ABOVE. OVERHEAD PROTECTION MAINTAIN OPEN TRAVEL LANES AT EQUIPMENT BAY DOORS AND DRIVEWAY AT ALL TIMES. **3** OF 15






ROOF AREA: A

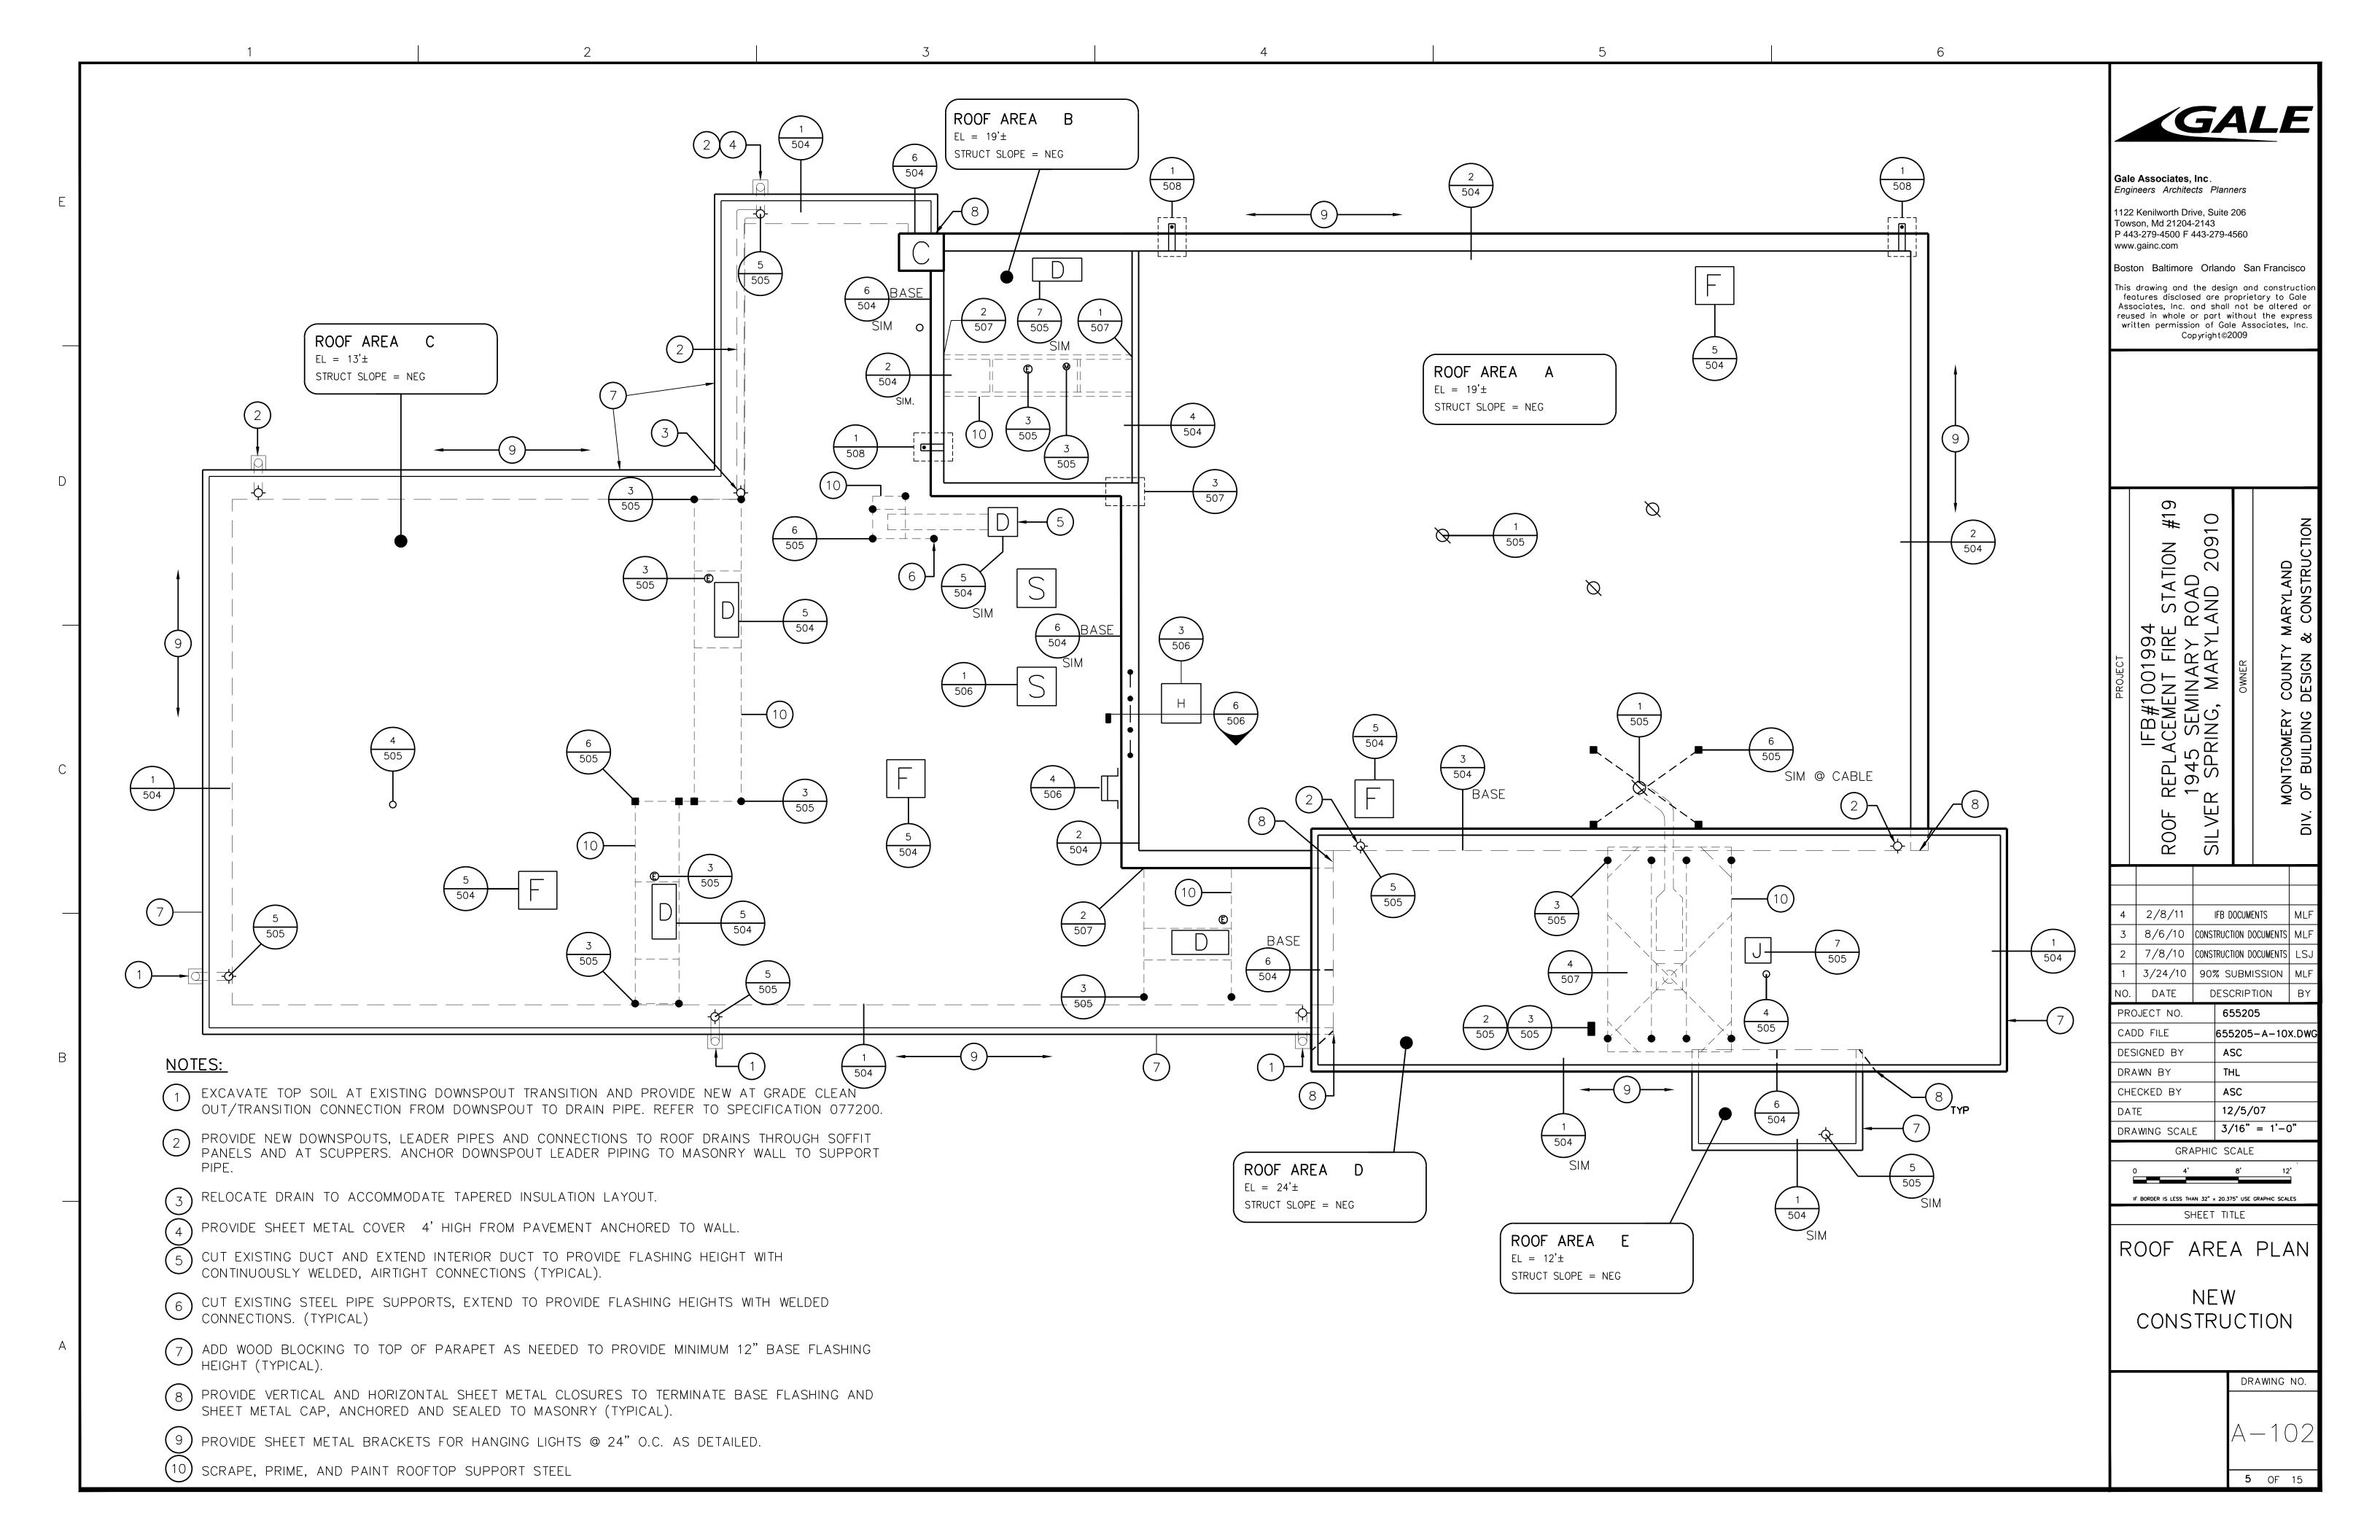


ROOF AREA: B,C,D & E

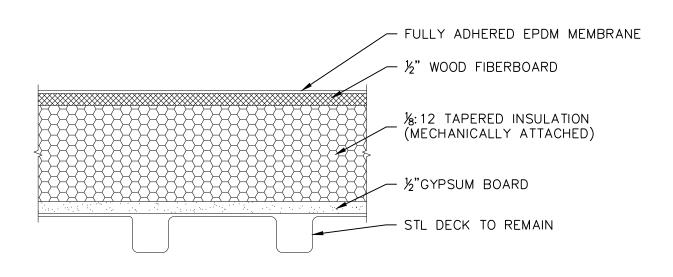


NEW CONSTRUCTION

ROOF AREA: A

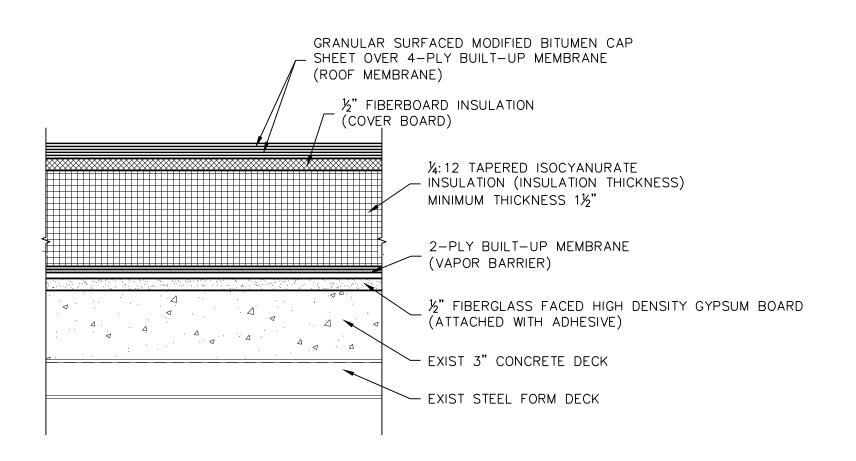

NOTE: VAPOR BARRIER TO BE UTILIZED AS TEMPORARY ROOF

ROOF AREA: B,C,D & E

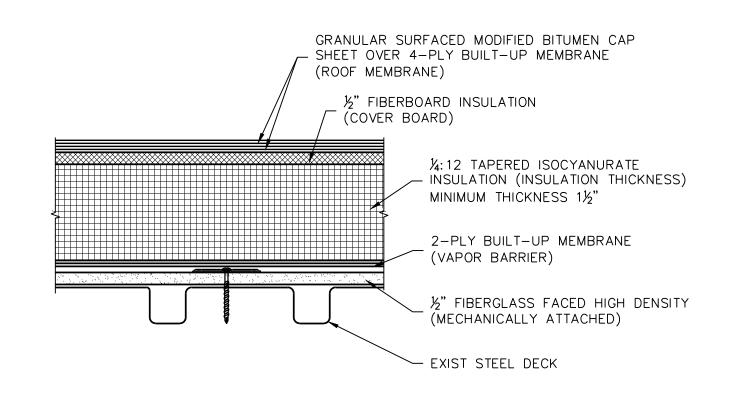

NOTE: VAPOR BARRIER TO BE UTILIZED AS TEMPORARY ROOF



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PROJECT	ROOF REPLACEMENT FIRE STATION #19	SILVER SPRING, MARYLAND 20910	OWNER	MONTGOMERY COUNTY MARYLAND	DIV. OF BUILDING DESIGN & CONSTRUCTION
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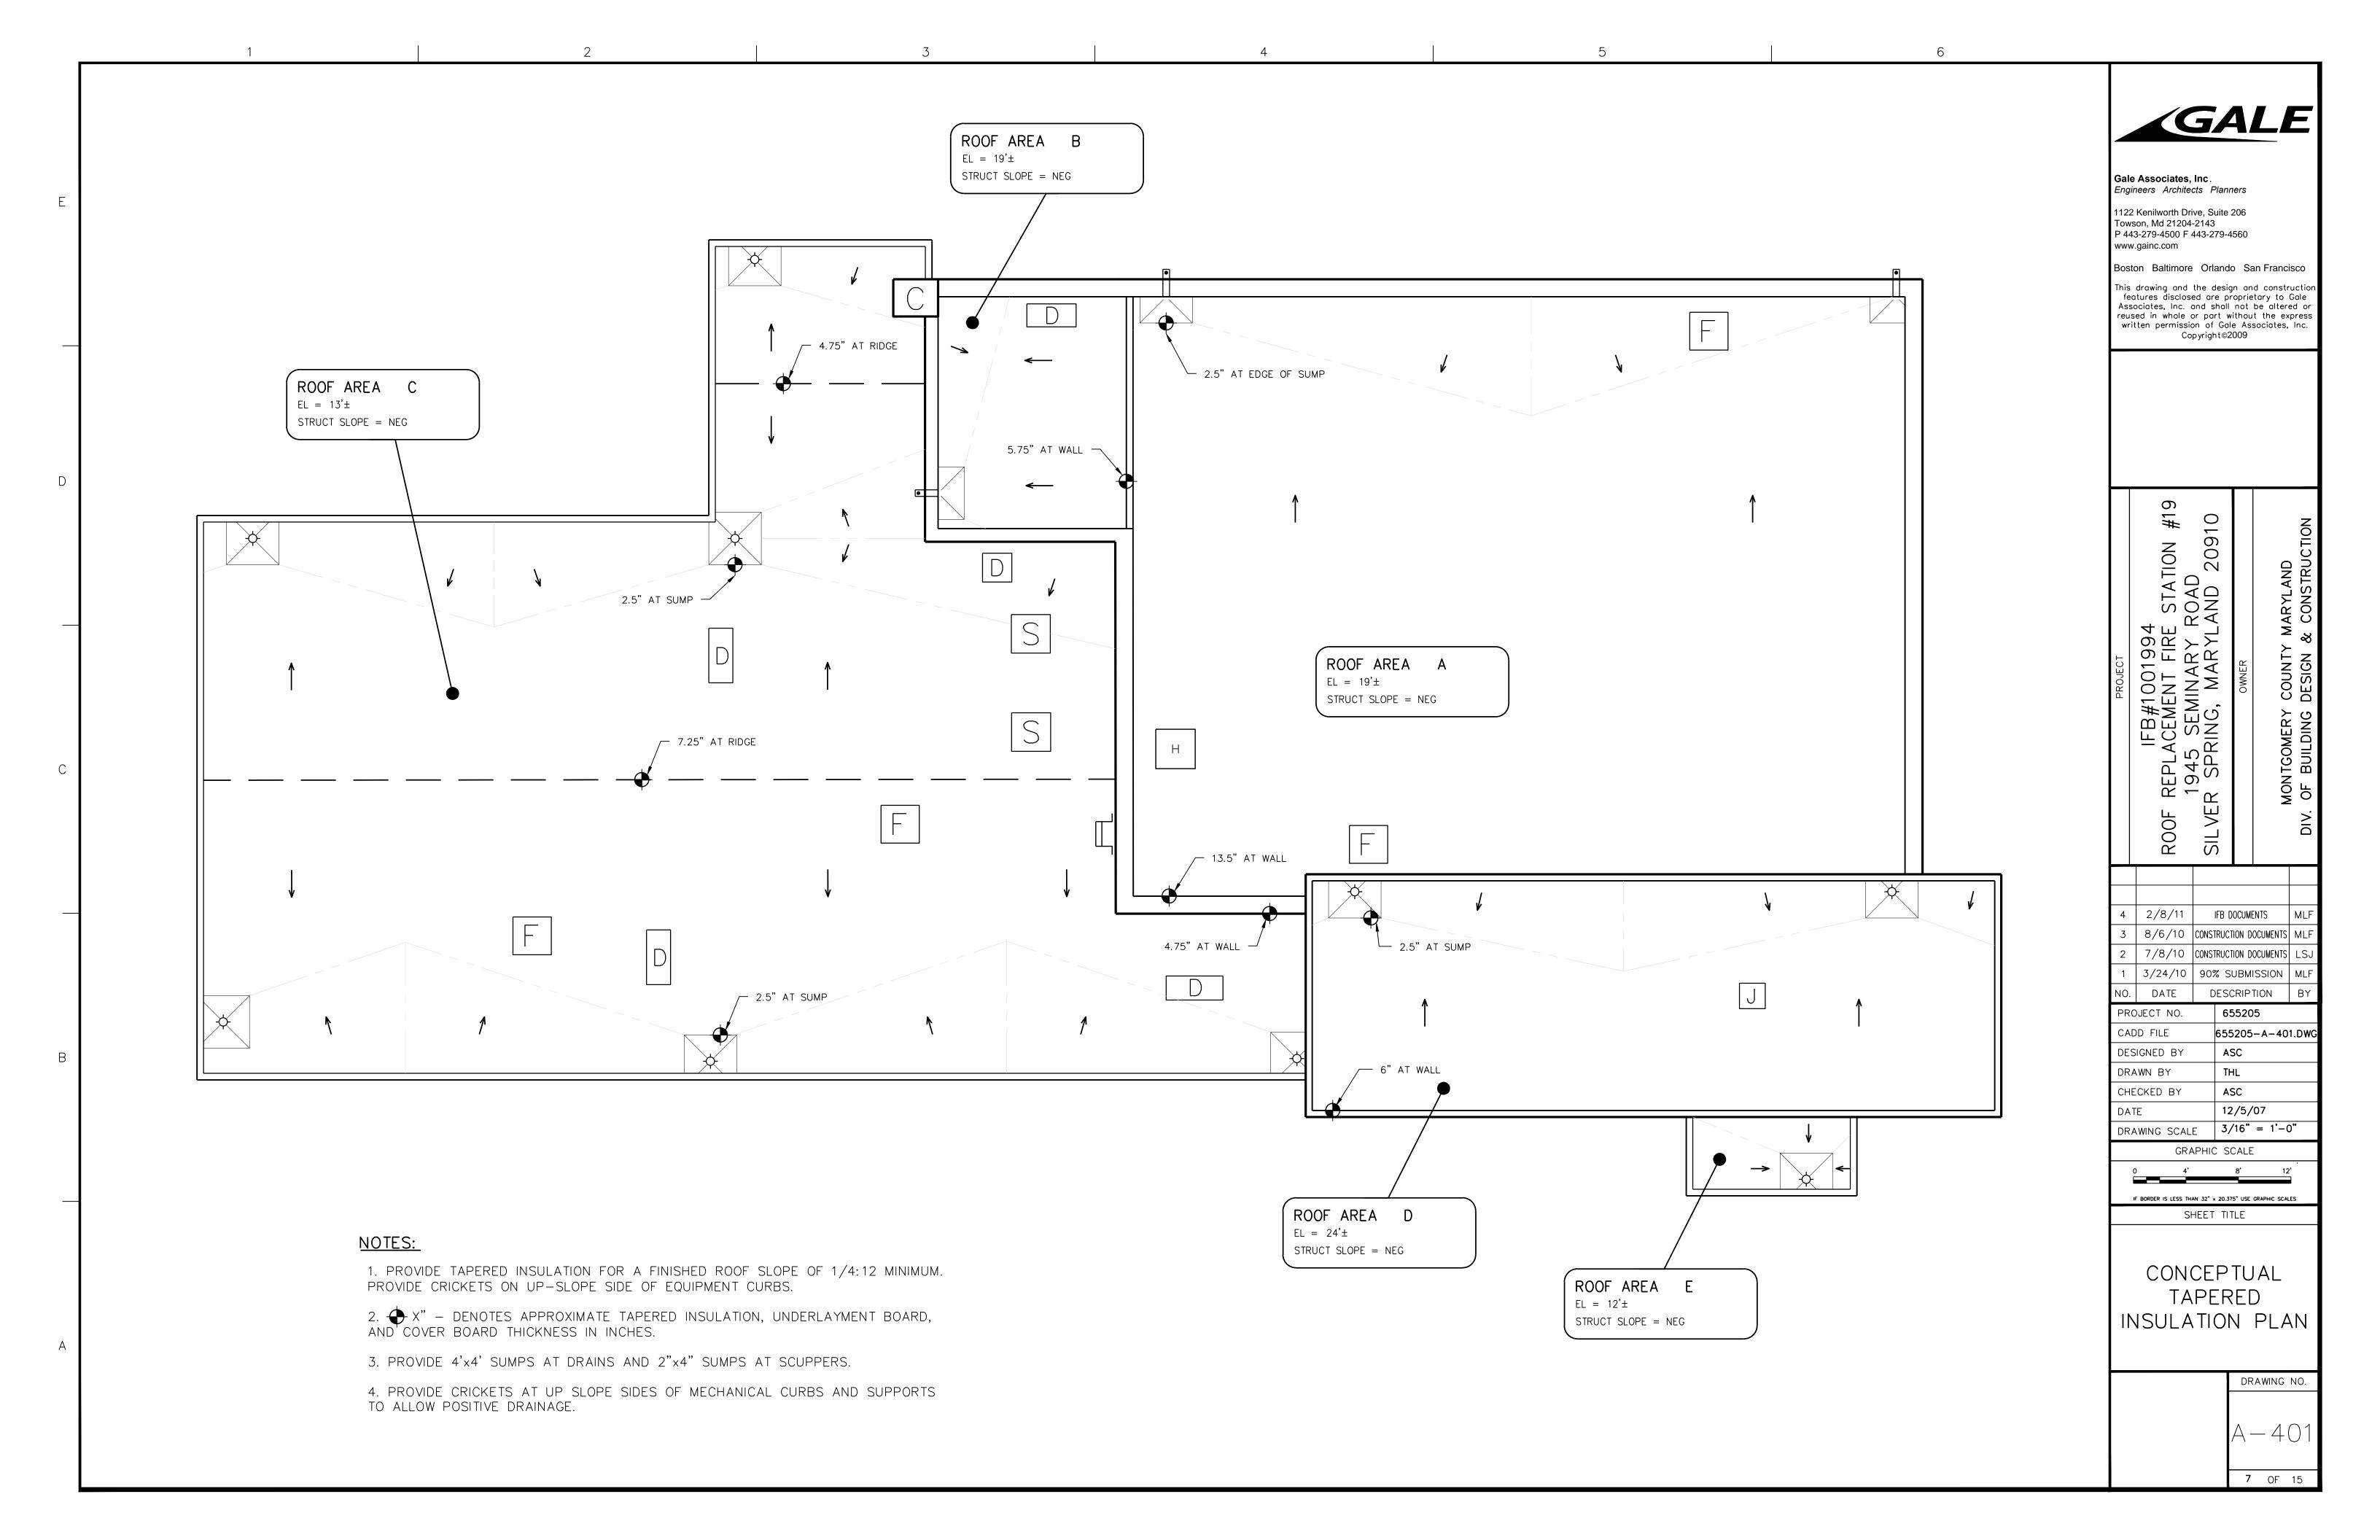
DRAWING SCALE


GRAPHIC SCALE


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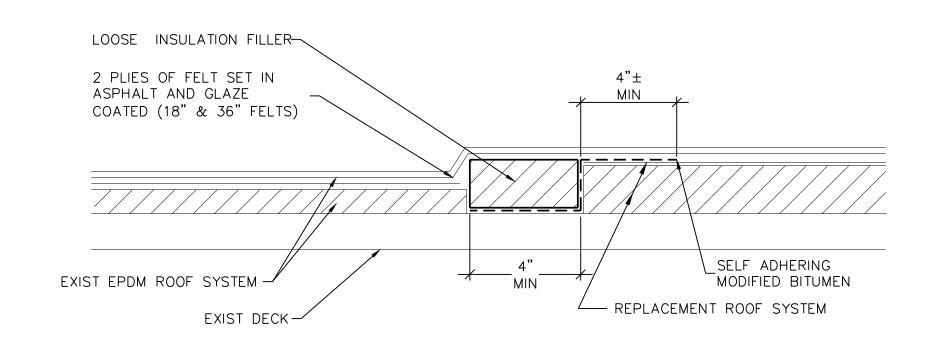
IF BORDER IS LESS THAN 32" × 20.375" USE GRAPHIC SCALES

ROOF SYSTEM CROSS-SECTIONS






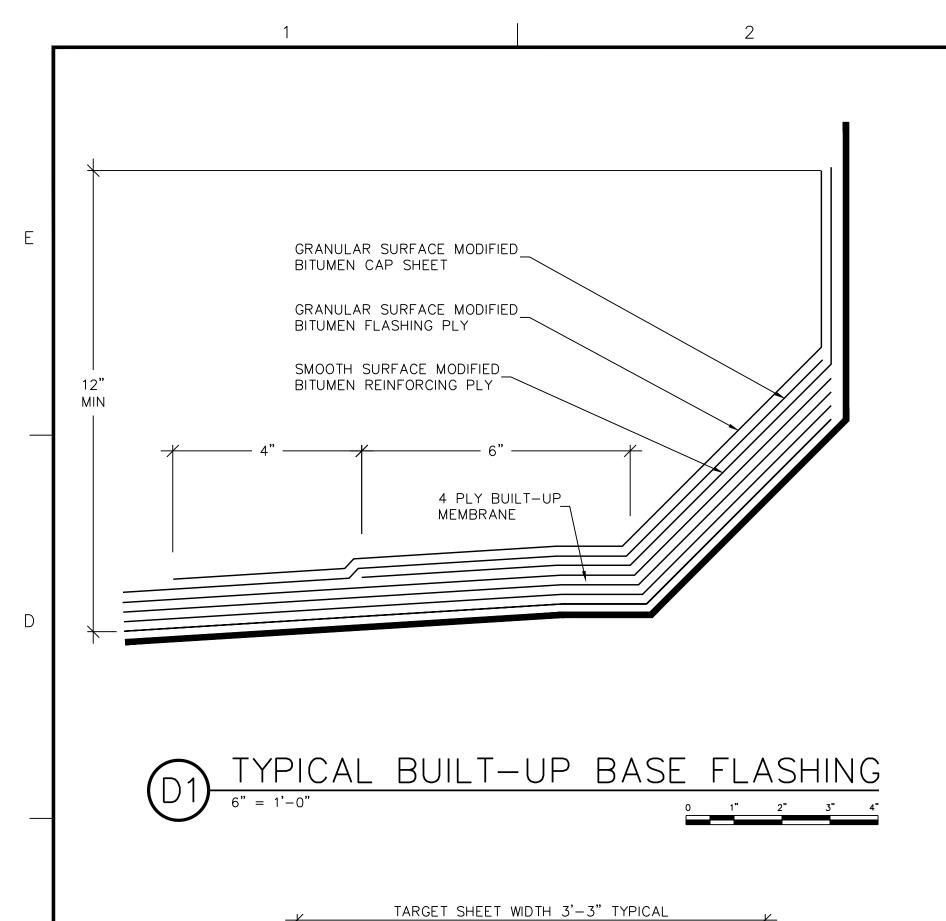

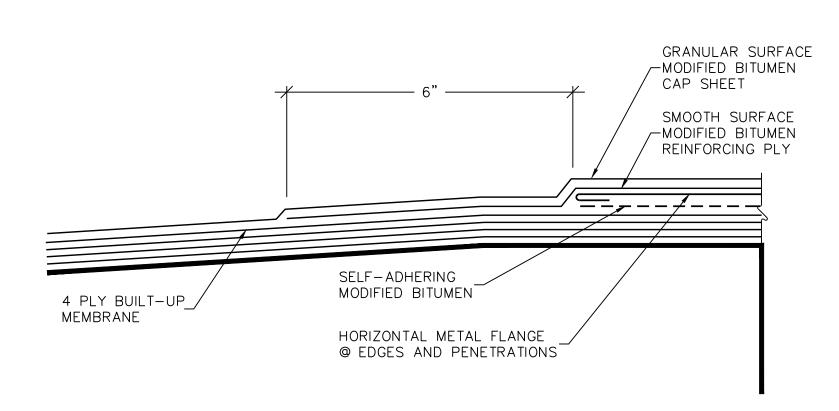

TYPICAL BUILT-UP STRIP FLASHING

TYPICAL TEMPORARY TIE-IN CONSTRUCTION

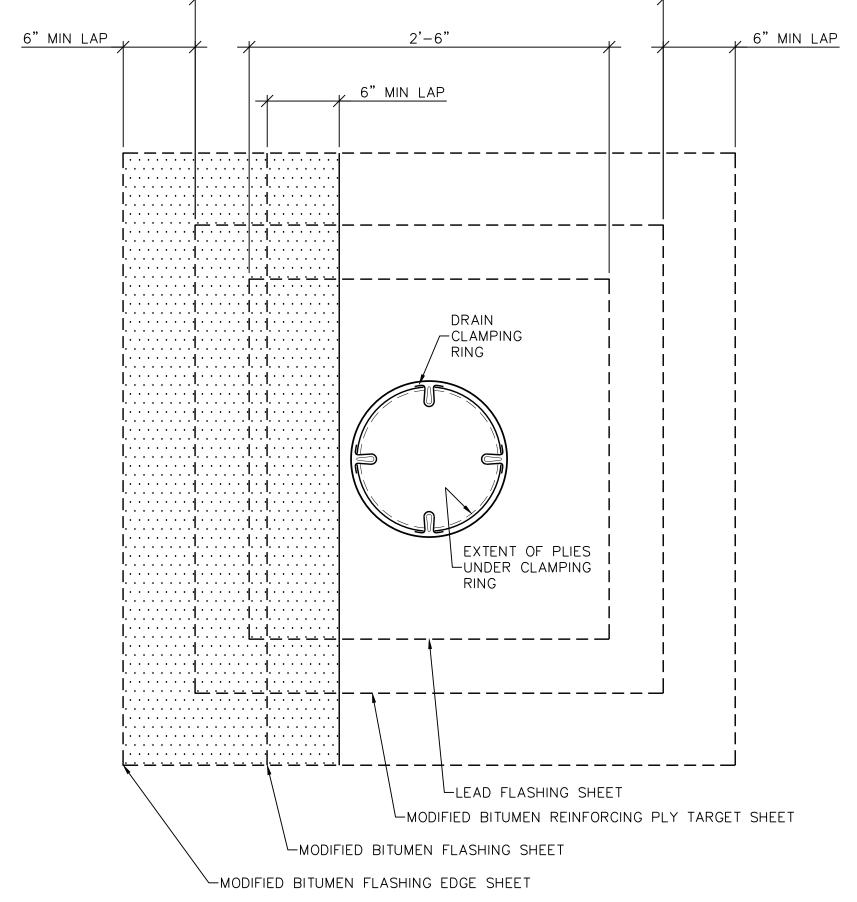


TYPICAL BUILT-UP DRAIN FLASHING

1-1/2" = 1'-0"

1-1/2" = 1'-0"

NOTE: DELETE FLASHING SHEET PLY FOR CAP SHEET ROOFS

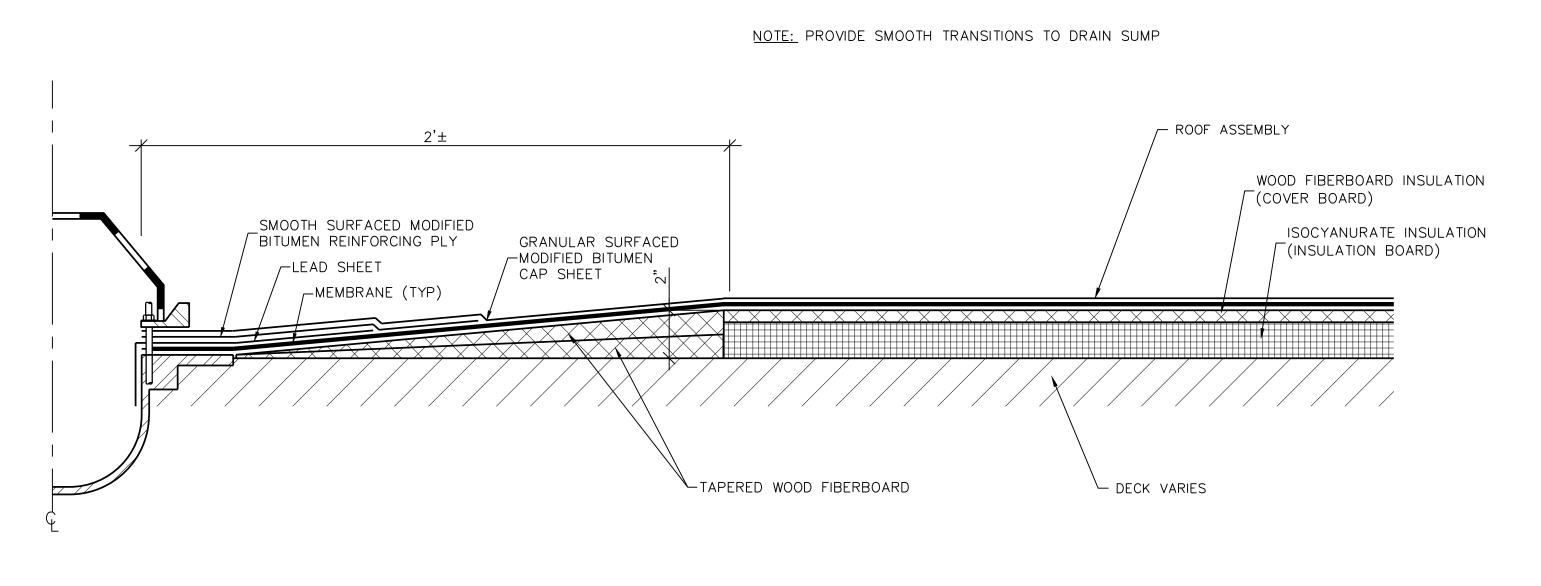



CHECK GRAPHIC SCALES PRIOR TO SCALING DRAWING

GALE

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TYPICAL ROOF

FLASHING

DETAILS

DRAWING NO.

8 OF 15

